

Tel: 416-392-5900 Fax: 416-392-5934

2020-02-07

Request for Tenders for Polar Bear Exhibit and Holding Modifications

RFT No.: TZC T 03-2020-01

ADDENDUM 3

This addendum shall be incorporated into, and form part of RFT No.: TZC T 03-2020-01 and take precedence over all requirements of the previously issued bid documents including plans. This addendum must be signed by the bidder (signing officer) in the appropriate space and must be attached to the form for submission by the bidder. This addendum consists of **TWO (2)** page(s) and the documents listed below.

1. DELETE PRICING FORM:

Rev 2 – APPENDIX III

REPLACE WITH PRICING FORM:

Rev 3 – APPENDIX III

2. DELETE DRAWINGS:

Rev 1 – A1.01 DEMO EXHIBIT SITE PLAN

Rev 1 - A1.02 PROPOSED EXHIBIT SITE PLAN

REPLACE WITH DRAWINGS:

Rev 2 - A1.01 DEMO EXHIBIT SITE PLAN

Rev 2 – A1.02 PROPOSED EXHIBIT SITE PLAN

3. ADD DRAWINGS:

A-200 – Polar Bear Holding Building Ground Floor Plan

A-210 - Polar Bear Holding Building Elevations

A-211 - Polar Bear Holding Building Elevations

A-220 - Polar Bear Holding Building Sections

A-300 – Polar Bear Underwater Viewing Area Plan

A-320 – Polar Bear Underwater Viewing Area Sections & Interior Elevations

Receipt of the addendum shall be acknowledged as part of your submission.

The Board of Management of the Toronto Zoo reserves the right to reject any or all quotations or to accept any quotation, should it deem such action to be in its interests.

If you have any queries regarding this matter, please contact Mr. Peter Vasilopoulos, Supervisor, Purchasing & Supply, at 416-392-5916.

Yours truly,

Peter Vasilopoulos Supervisor, Purchasing & Supply

I/we hereby acknowledge receipt of this addendum and make allowance in my bid.			
	_		
Signed (Must be Signing Officer of Firm)			
	_		
Name of Firm			
	_		
Date			



ZOO 2020-02-05

TZC T 03-2020-01 POLAR BEAR EXHIBIT & HOLDING MODIFICATIONS PART 5- PRICING FORMS

Rev 3 – APPENDIX III - ADDITIONAL PRICES (Due 24 hours after stipulated closing date)


(**not included** in Total Tender Price)


All prices are to include the supply and installation of all labour, material, taxes (excluding Harmonized Sales Tax), charges, payroll, burden and profit.


ITEM DESCRIPTION PRICE

A1	Enlarge animal transfer door between pool & maternity exhibits	\$ Increase / Reduction
B1	Install shade sail in maternity exhibit	8
		Increase / Reduction
B2	Install shade sail in pool exhibit – over pool	
		\$
		Increase / Reduction
B3	Install shade sail in pool exhibit – over land	
		\$
		Increase / Reduction
C1	All work required to enlarge doors D01, D02, D03 & D04 in	
	the polar bear holding building. Includes all associated	\$
	rockwork.	Increase / Reduction
D1	All work required to enlarge the pool in the maternity	
	exhibit. Includes all associated services and rockwork.	\$
		Increase / Reduction

^{*} For each item, insert amount in the appropriate column to indicate whether the price change will result in an increase in, or a reduction of, the Total Tender Price.

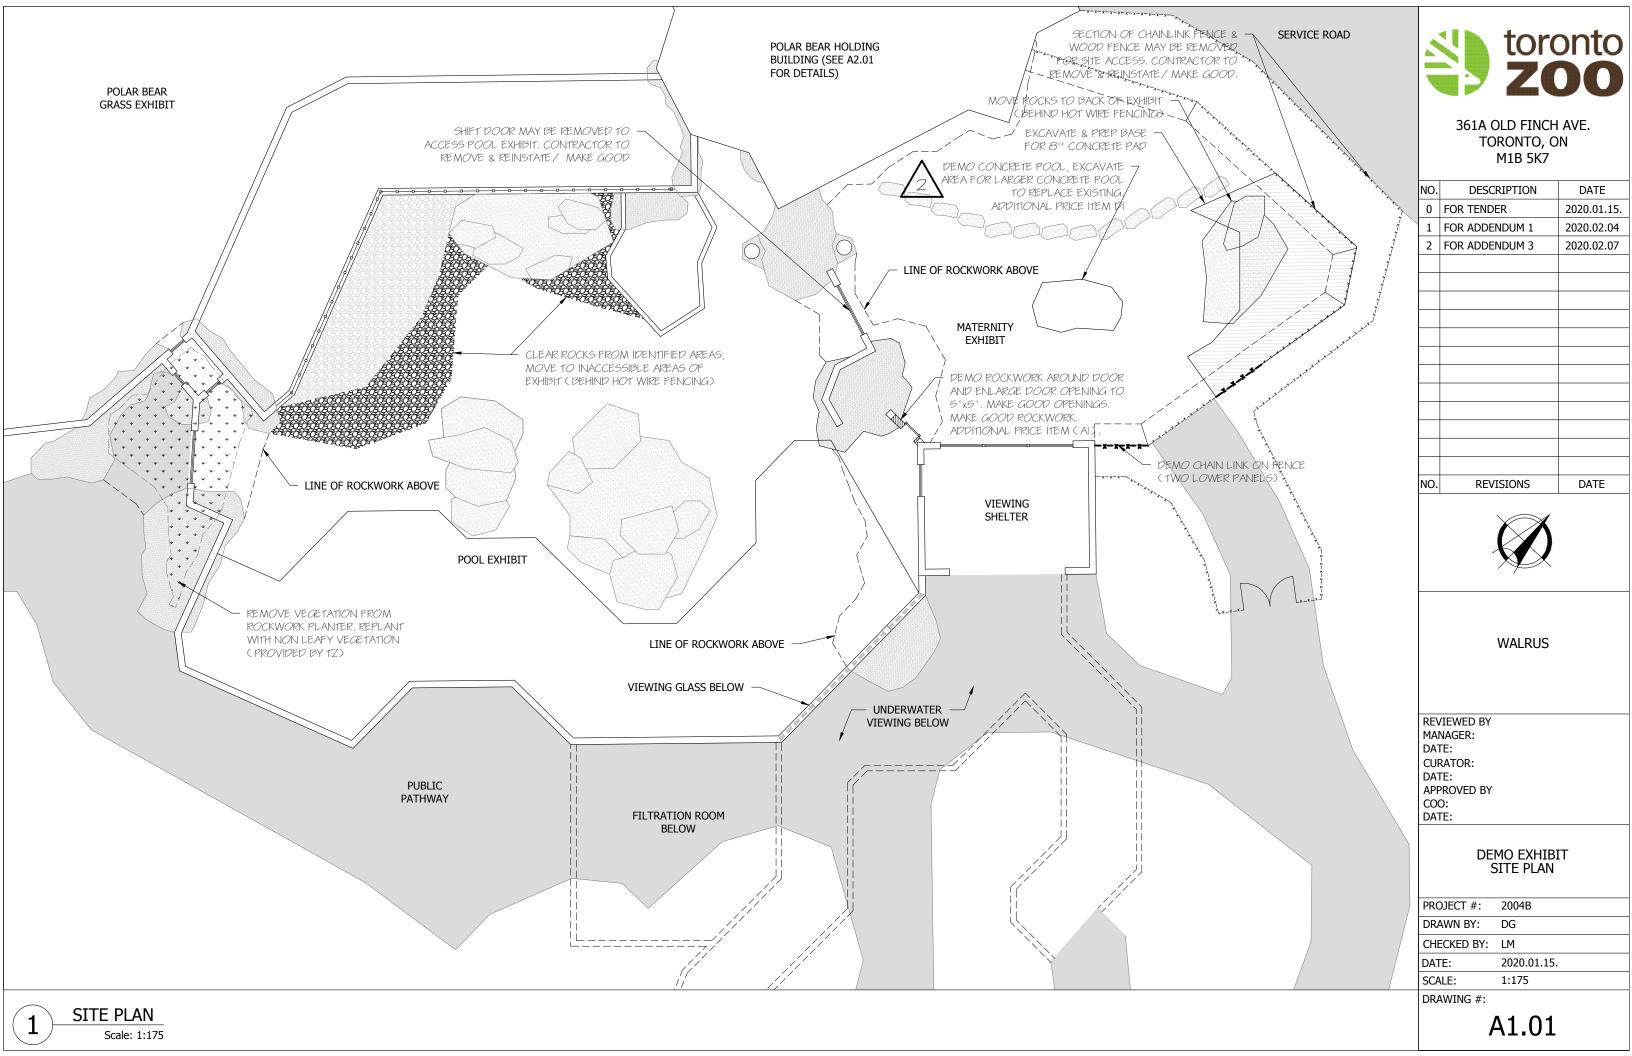

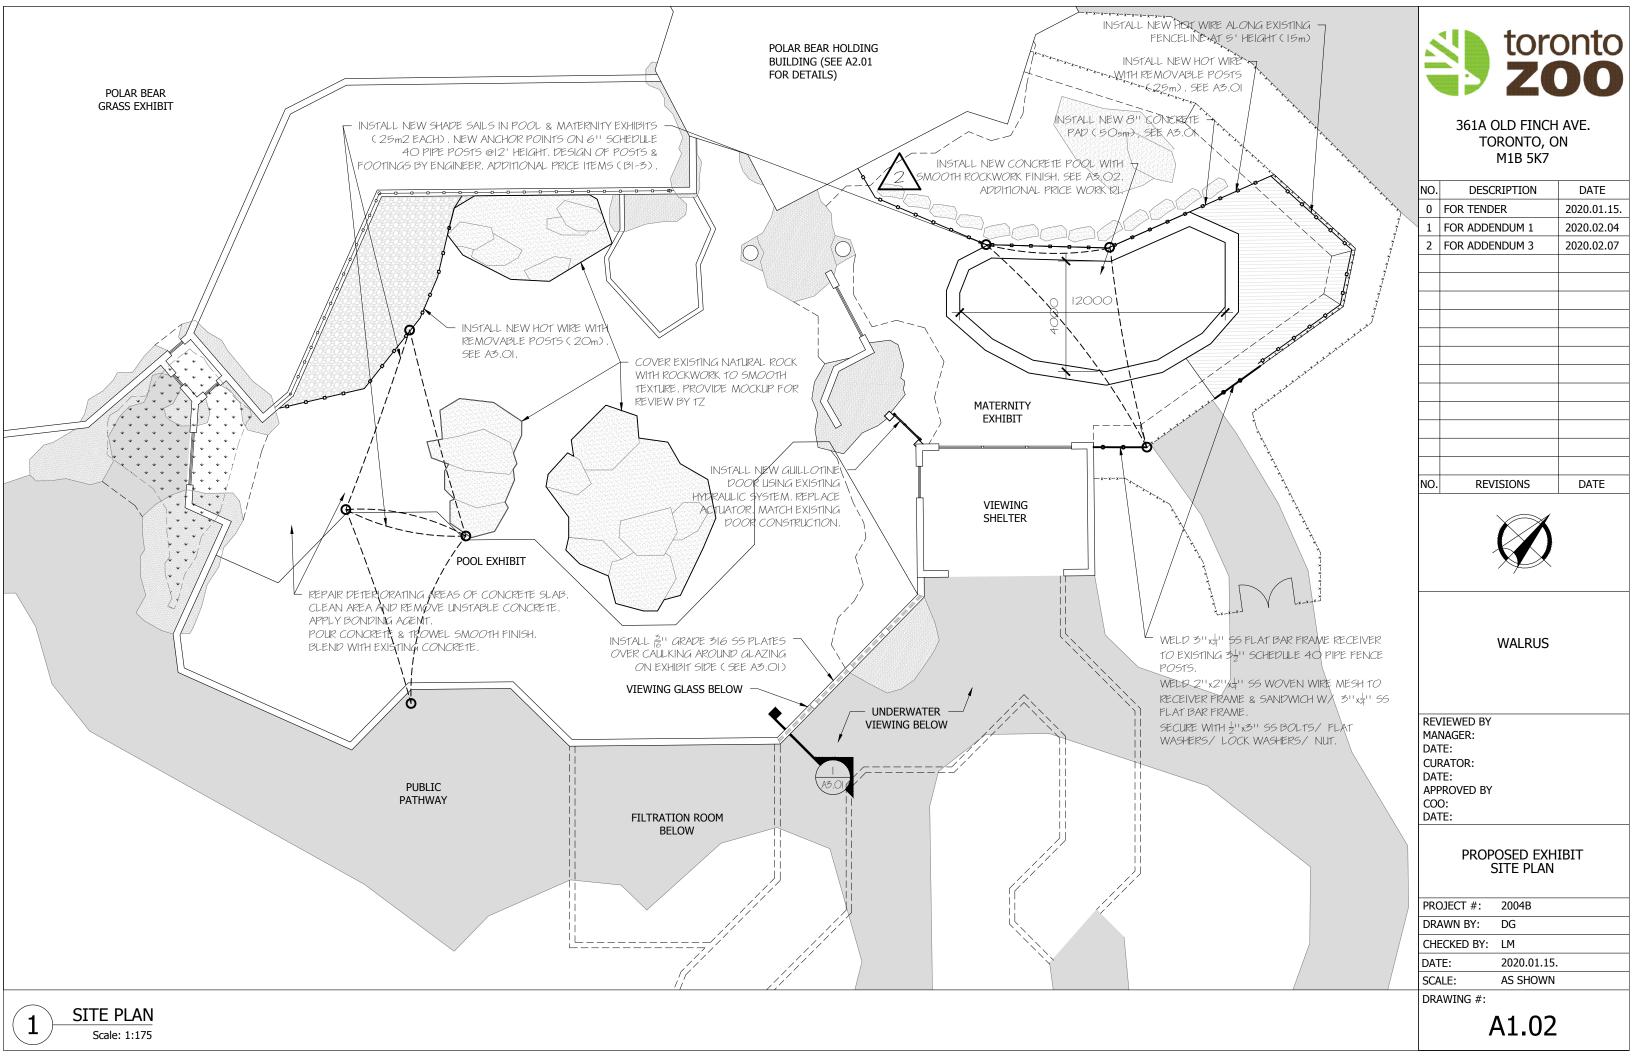

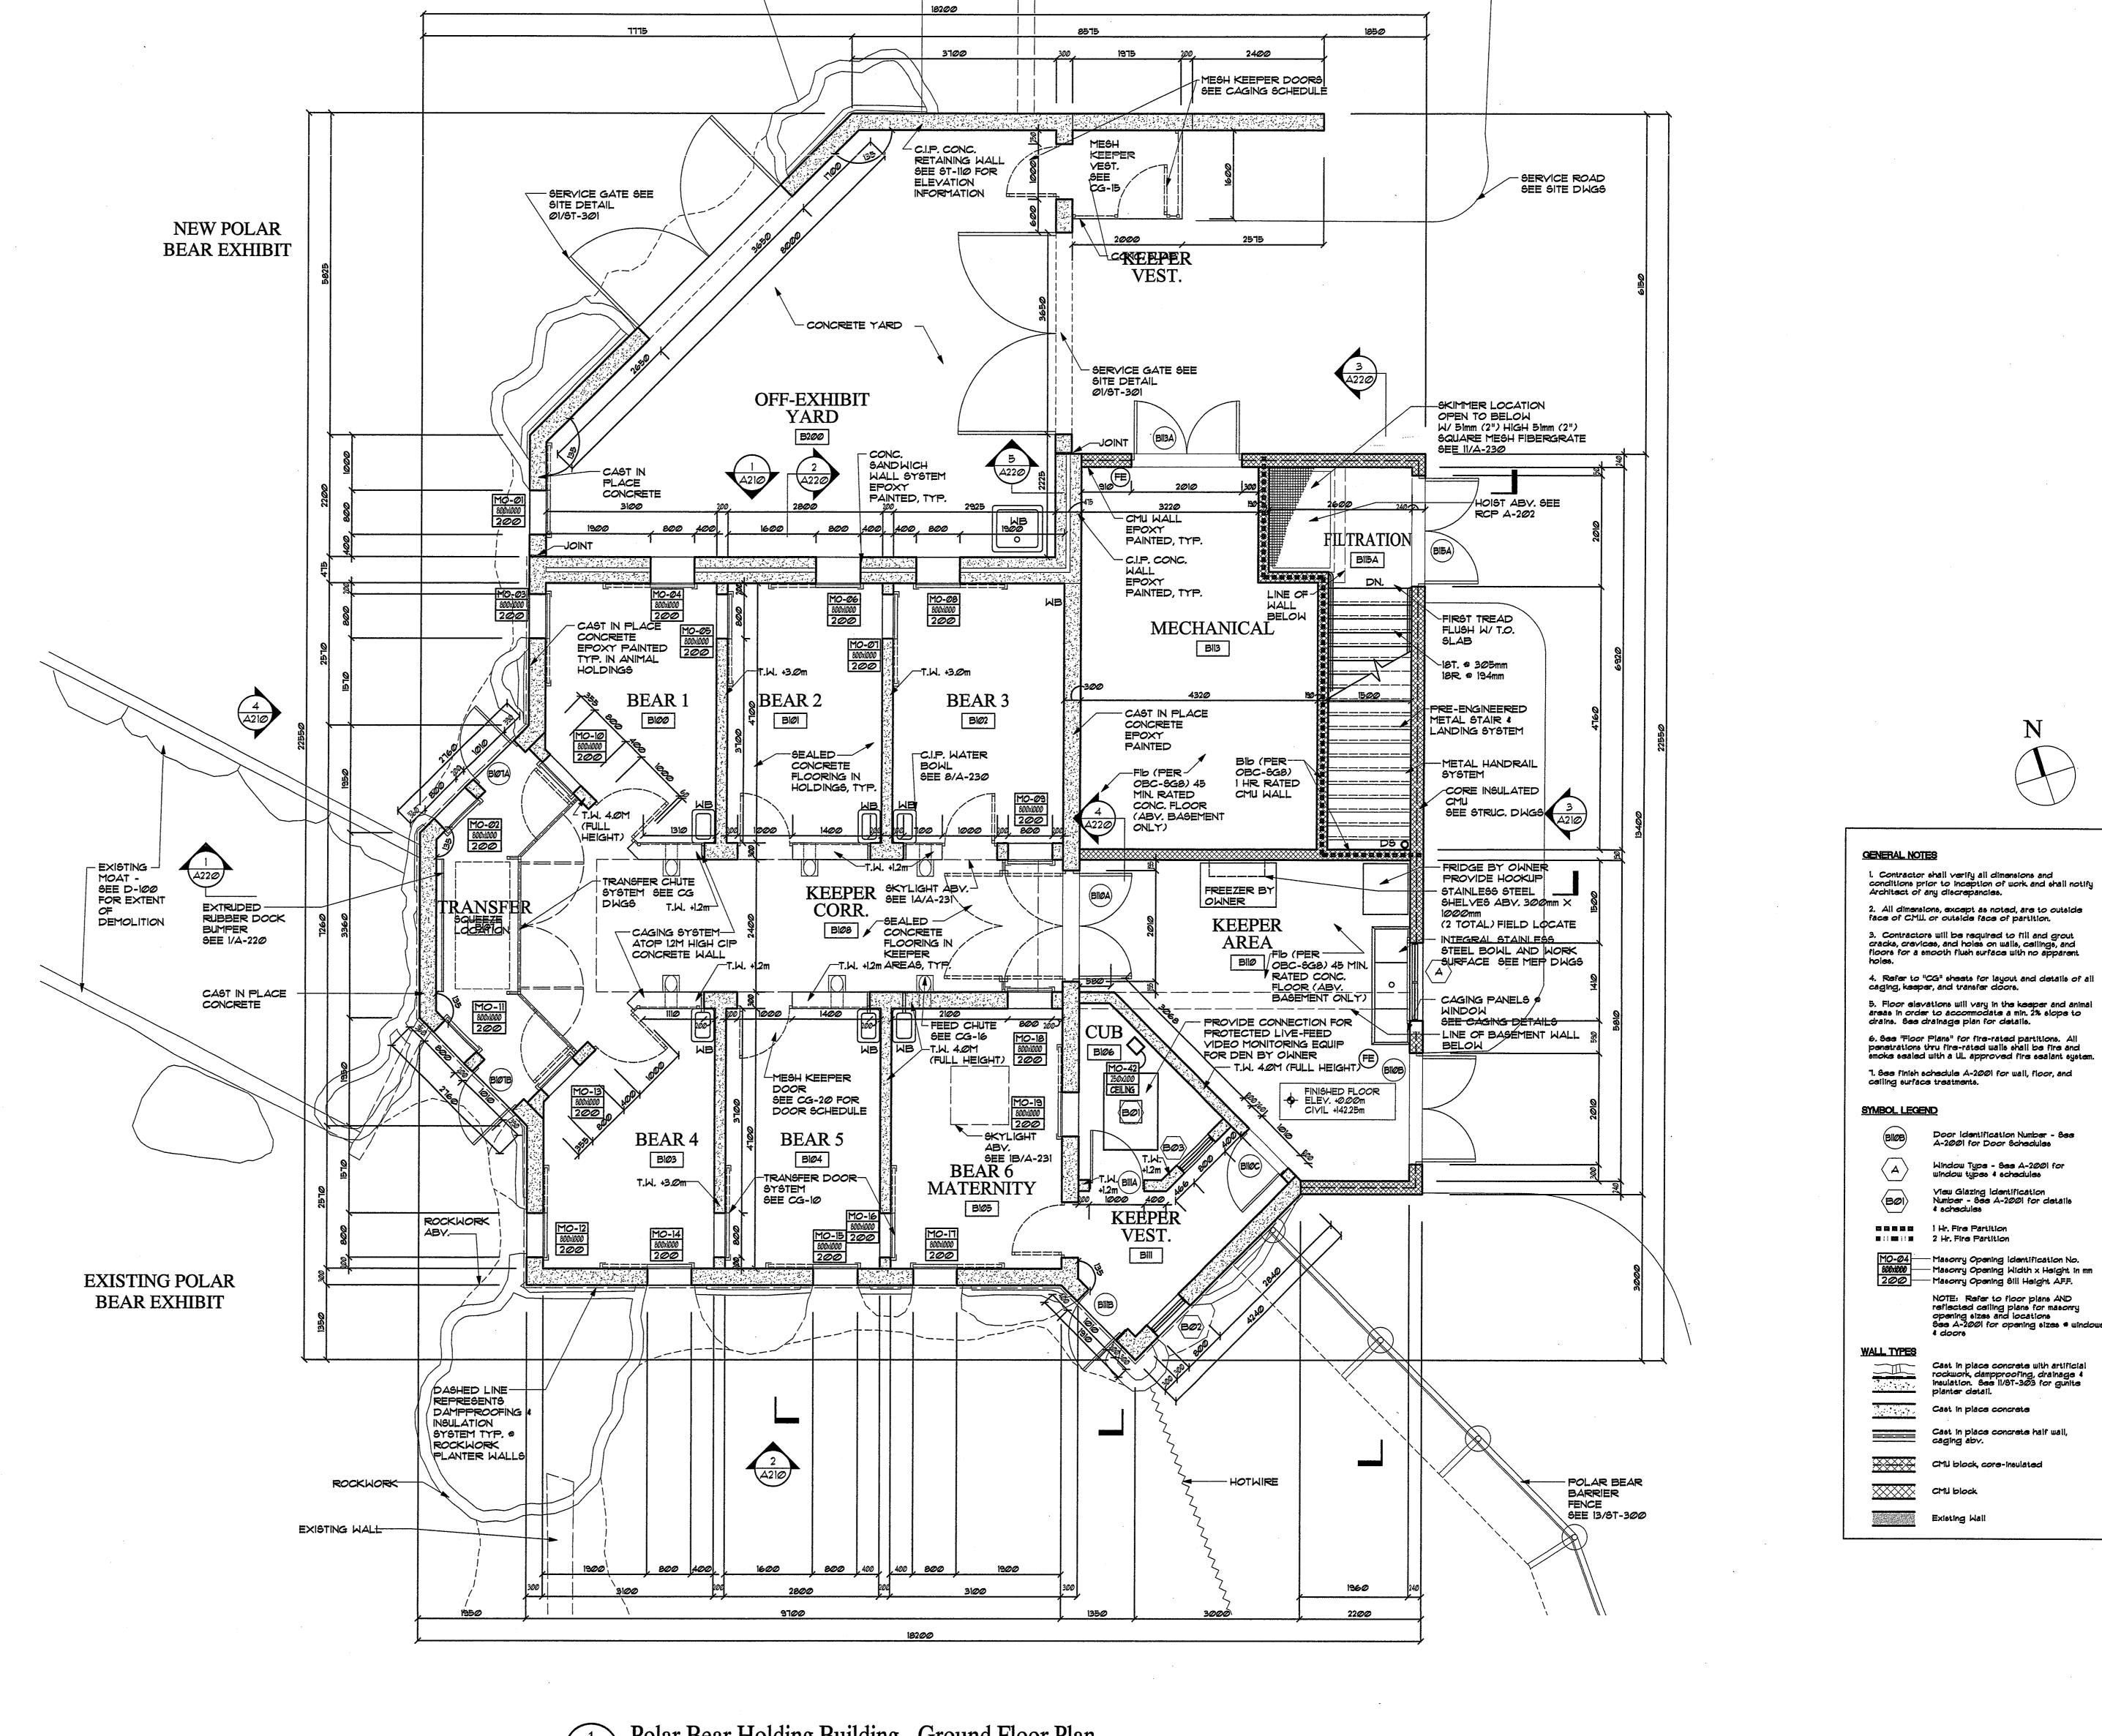

Polar Bear Holding Building - Ground Floor Plan

SCALE: 1:50

NOTE: ALL DIMENSIONS ARE MILLIMETERS (mm) UNLESS OTHERWISE NOTED. NOTE: See attached Building Code Matrix for Architect's qualification information.

Polar Bear Holding Building Ground Floor Plan Drawing No.

Project Number 05646 Project Manager JS Drawn JK Scale 1:50 Date March 2, 2007 Checked General Notes:

A-200

Door identification Number - Ses A-2001 for Door Schedules

Window Type - See A-2001 for

View Glazing Identification Number - See A-2001 for details

- Masonry Opening Identification No. - Masonry Opening Width x Height in mm

NOTE: Refer to floor plans AND

Cast in place concrete with artificial rockwork, dampproofing, drainage 4 insulation. See 11/37-303 for gunite

planter detail.

caging abv.

Cast in place concrete

Cast in place concrete half wall,

reflected ceiling plans for masonry opening sizes and locations see A-2001 for opening sizes windows

— Masonry Opening Sili Height AFF.

window types 4 schedules



Landscape Architects, Architects & Exhibit Designers
121 N Broad Street, 7th Floor
Philadelphia, PA 19107
(215) 564-0250

CLR_{design inc.} Valdor Engineering, Inc. Civil Engineers

(905) 264-0054

661 Chrislea Road, Suite 11 Woodbridge, Ontario L4L 8A3

Carruthers & Wallace A Division of Trow Associates Inc. **Structural Engineers**

Toronto, Ontario M6A 3B6

(416) 789-2600

970 Lawrence Avenue W., Suite 600

372 Bay Street, 18th Floor Toronto, Ontario M5H 2W9

(416) 366-0220

Guelph, Ontario N1H 3W4 (519) 824-8664

(800) 703-0740

Landplan Collaborative, Ltd. BaAM Productions


(360) 371-3107

T.A. Maranda


Consultants, Inc.

Issued for Tender and Permit - March 2, 2007

Revisions

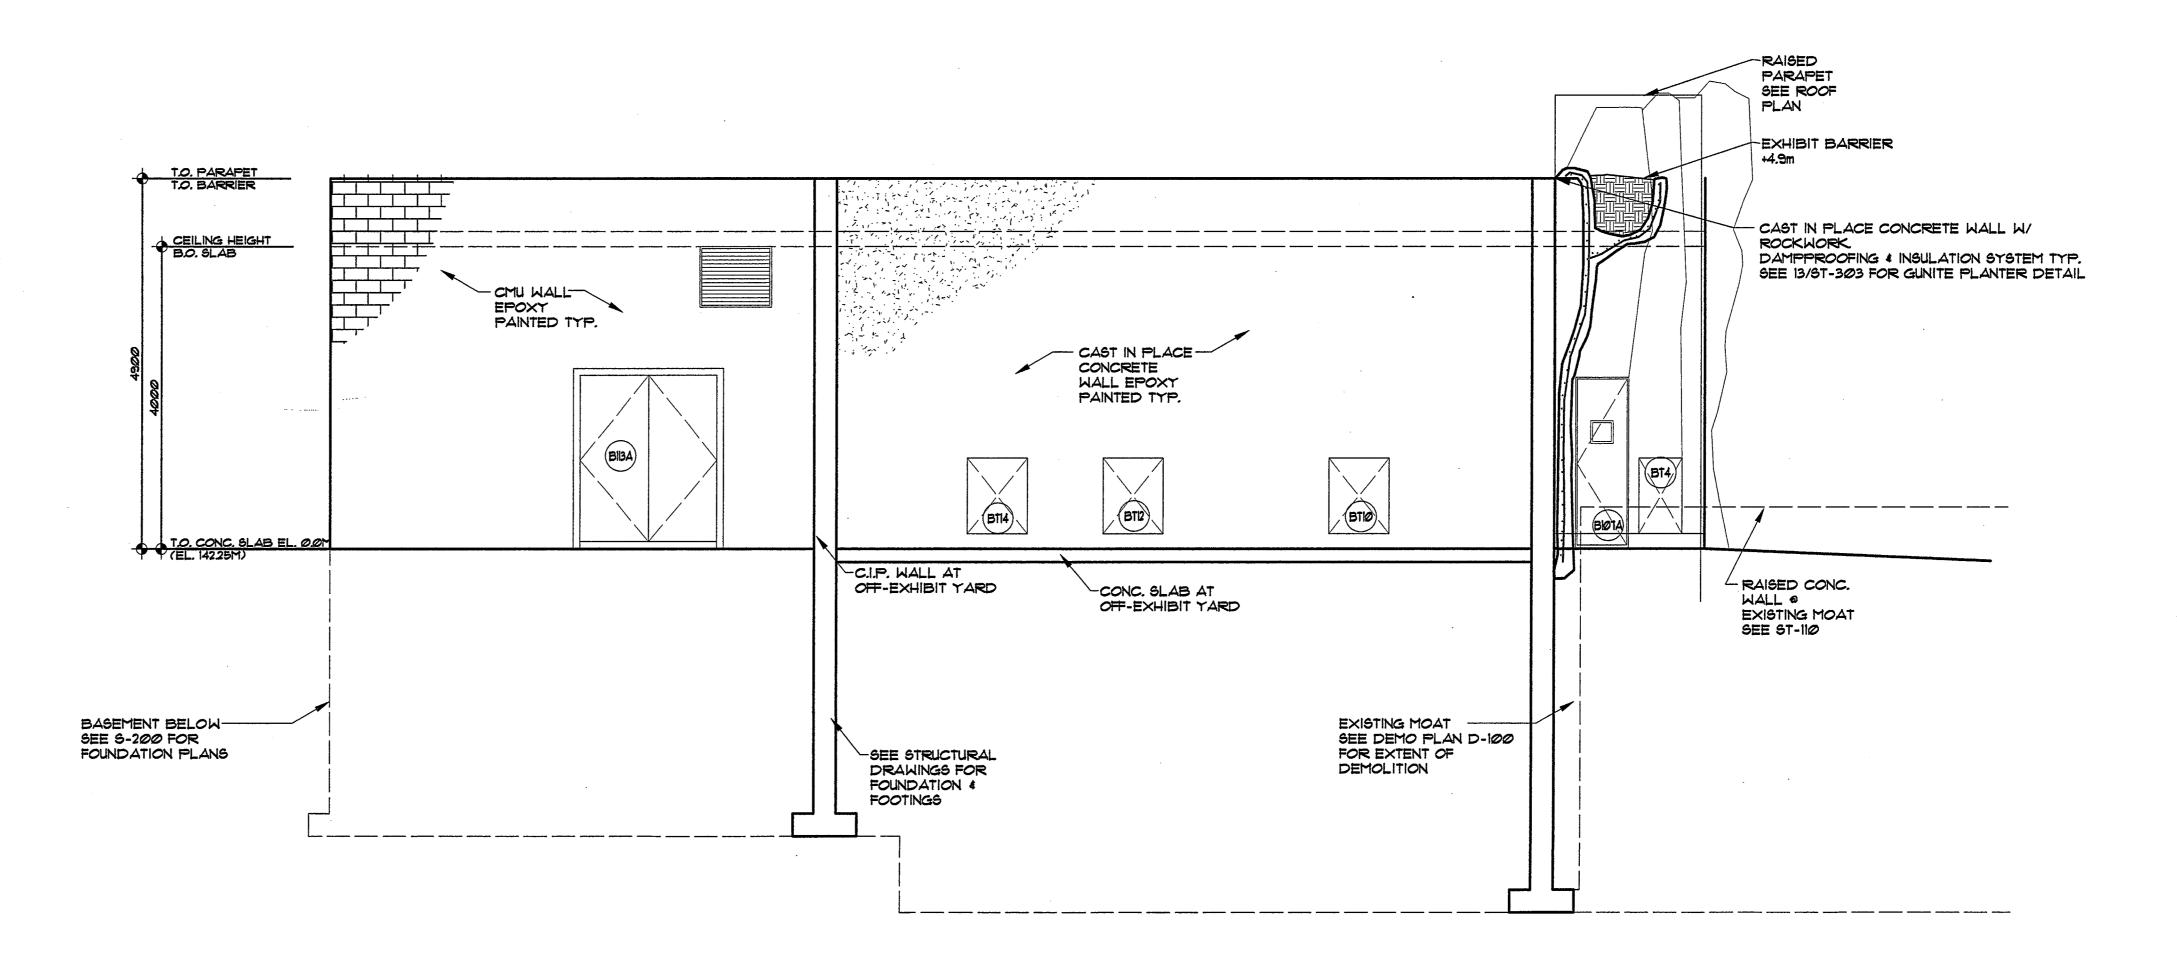

Polar Bear Holding Building - North Elevation

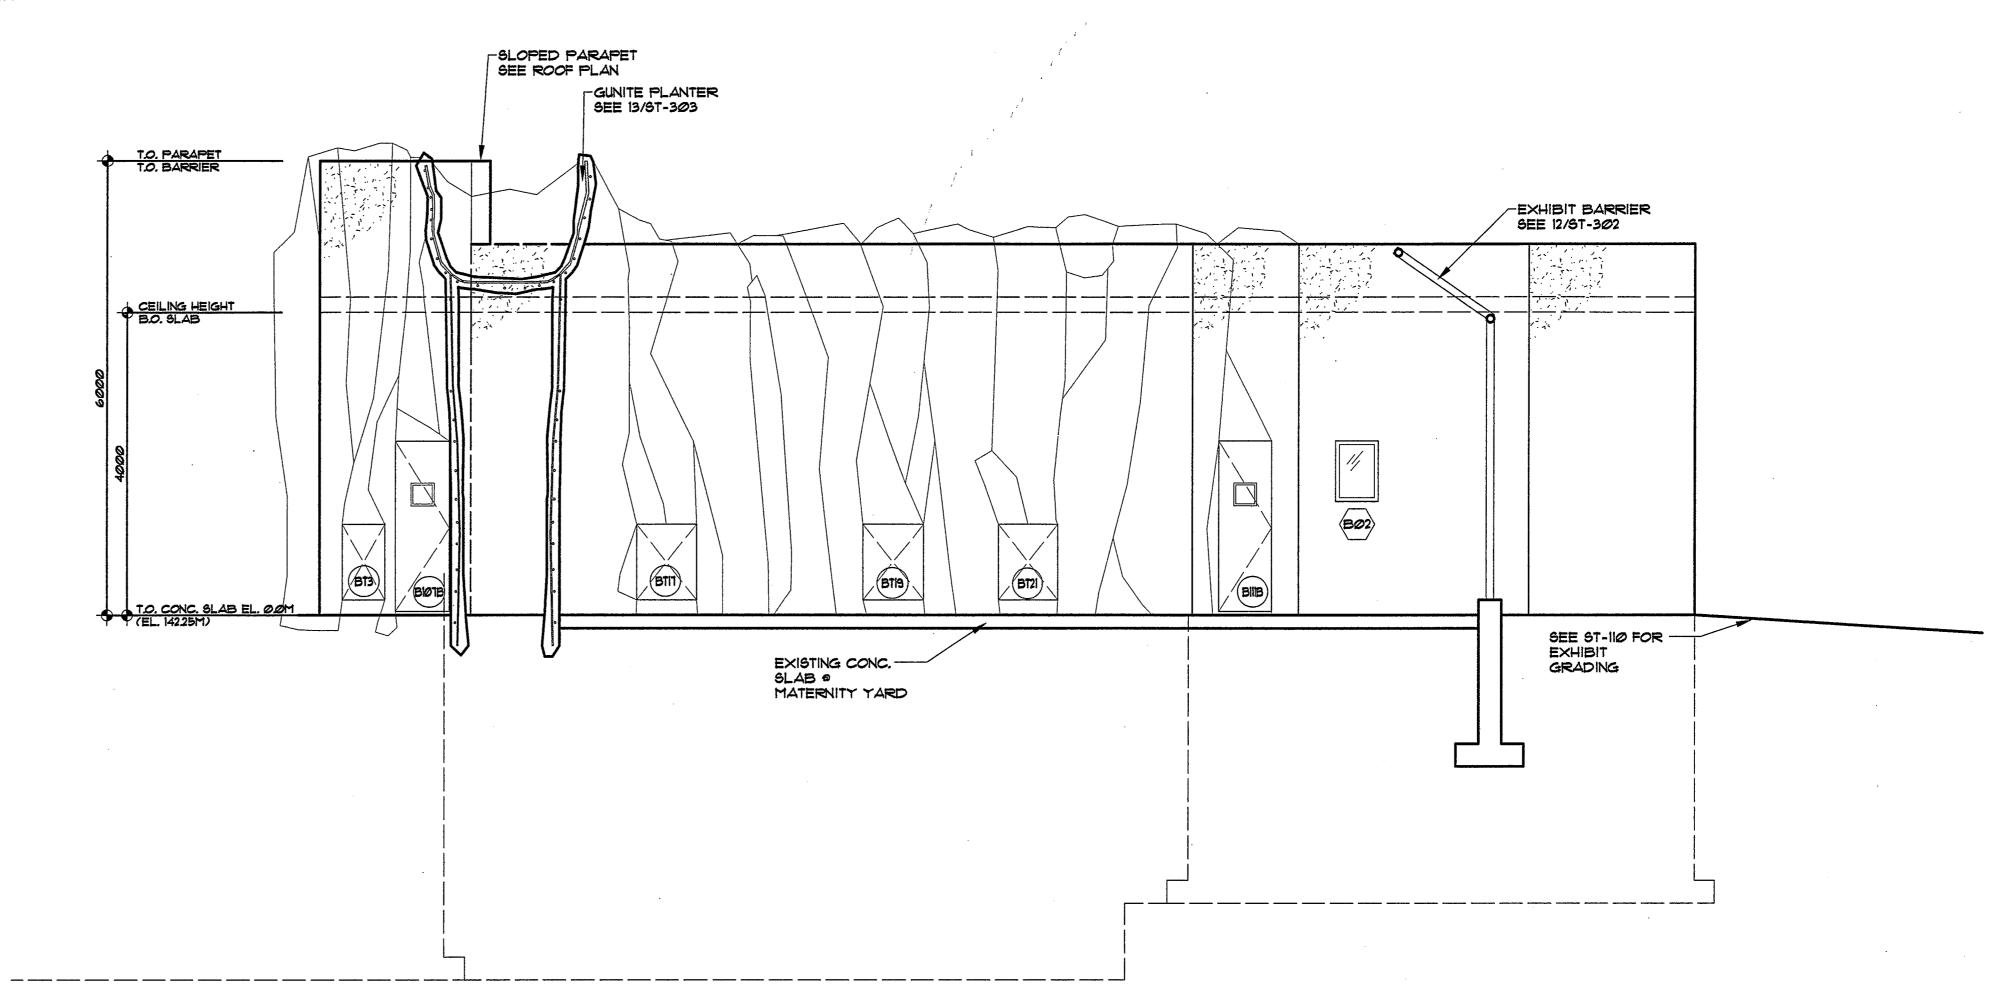

Polar Bear Holding Building - South Elevation

NOTE: ALL DIMENSIONS ARE MILLIMETERS (mm) UNLESS OTHERWISE NOTED. NOTE: See attached Building Code Matrix for Architect's qualification information.



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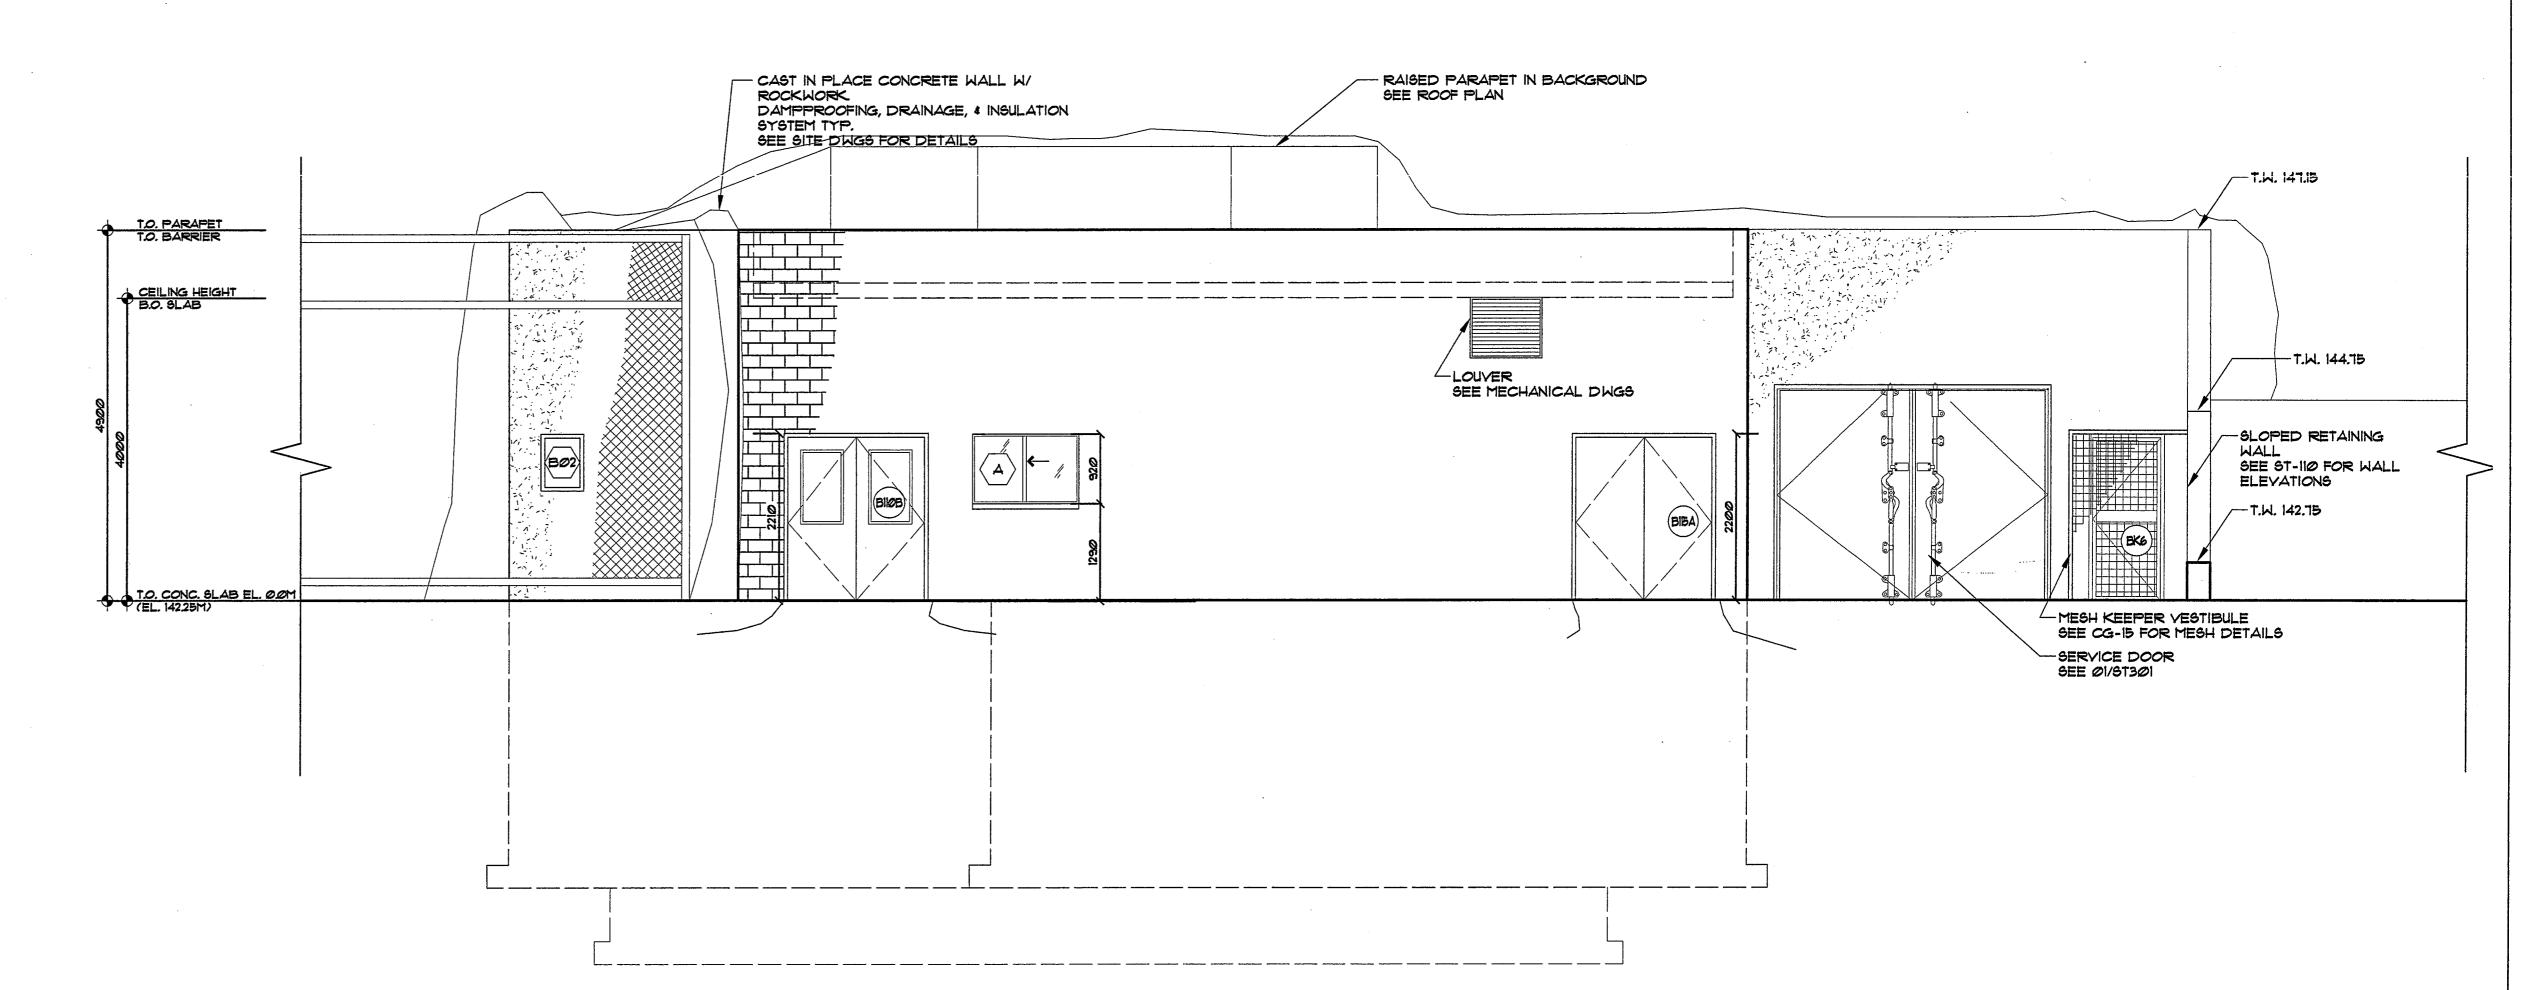
(800) 703-0740

T.A. Maranda Consultants, Inc. Landplan Collaborative, Ltd. BaAM Productions Water Systems Engineer 8616 Blue Grouse Way Blaine, WA 98230 (360) 371-3107


Revisions Issued for Tender and Permit - March 2, 2007 Polar Bear Holding Building Elevations Drawing No.

Project Number 05646 Project Manager JS Drawn JK Scale 1:50 Date March 2, 2007 Checked JB General Notes:

A-210



Polar Bear Holding Building - East Elevation

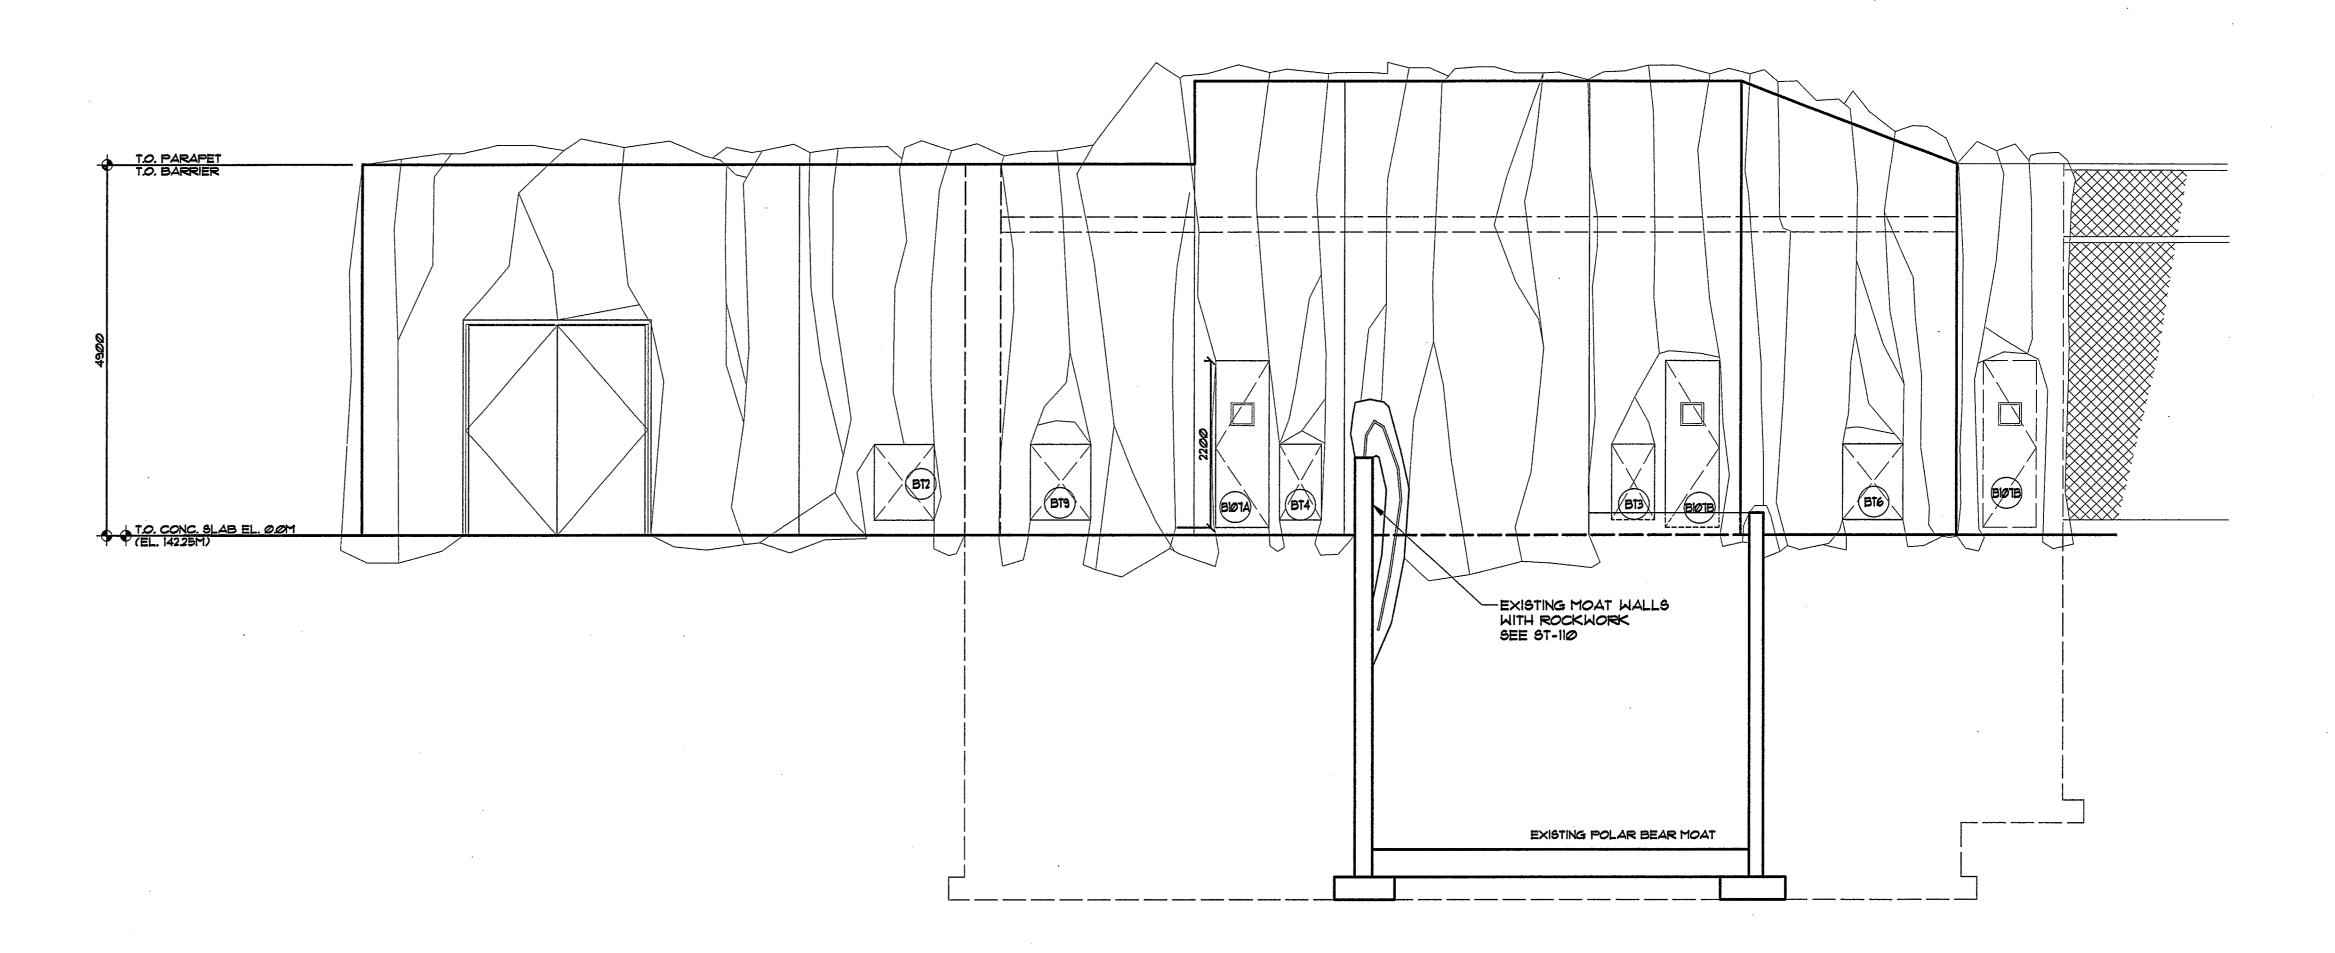

Polar Bear Holding Building - West Elevation

SCALE: 1:50

NOTE: ALL DIMENSIONS ARE MILLIMETERS (mm) UNLESS OTHERWISE NOTED.

NOTE: See attached Building Code Matrix for Architect's qualification information.

Polar Bear Holding Building

Drawing No. A-211 Scale 1:50
Date March 2, 2007

TUNDRA STOROLO PROJECT STOROLO ZOO

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Landplan Collaborative, Ltd. BaAM Productions **Interpretive Design** 662 King Street West, Suite 101 Toronto, Ontario M5V 1M7


(800) 703-0740


T.A. Maranda Consultants, Inc. Water Systems Engineers 8616 Blue Grouse Way Blaine, WA 98230 (360) 371-3107

Revisions

Issued for Tender and Permit - March 2, 2007

Elevations Project Number 05646
Project Manager JS Drawn JK
Checked
General Notes:

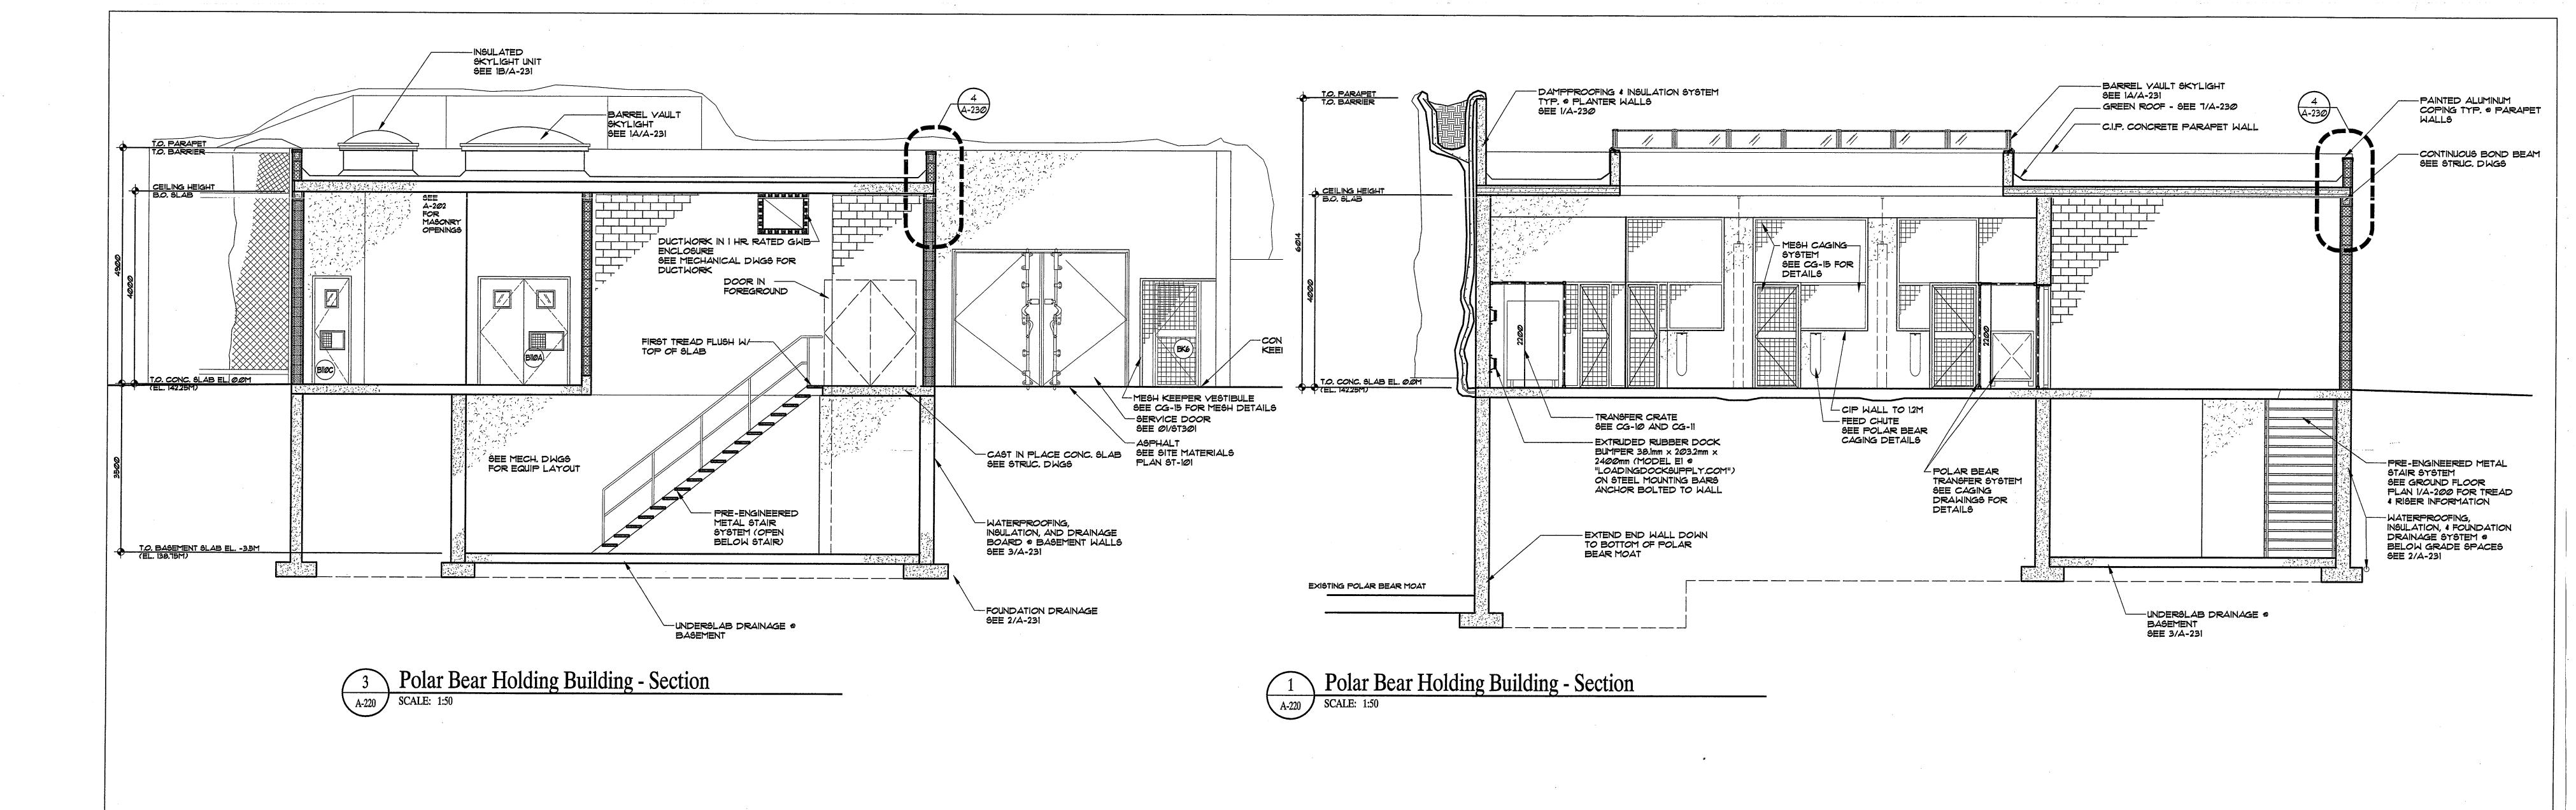

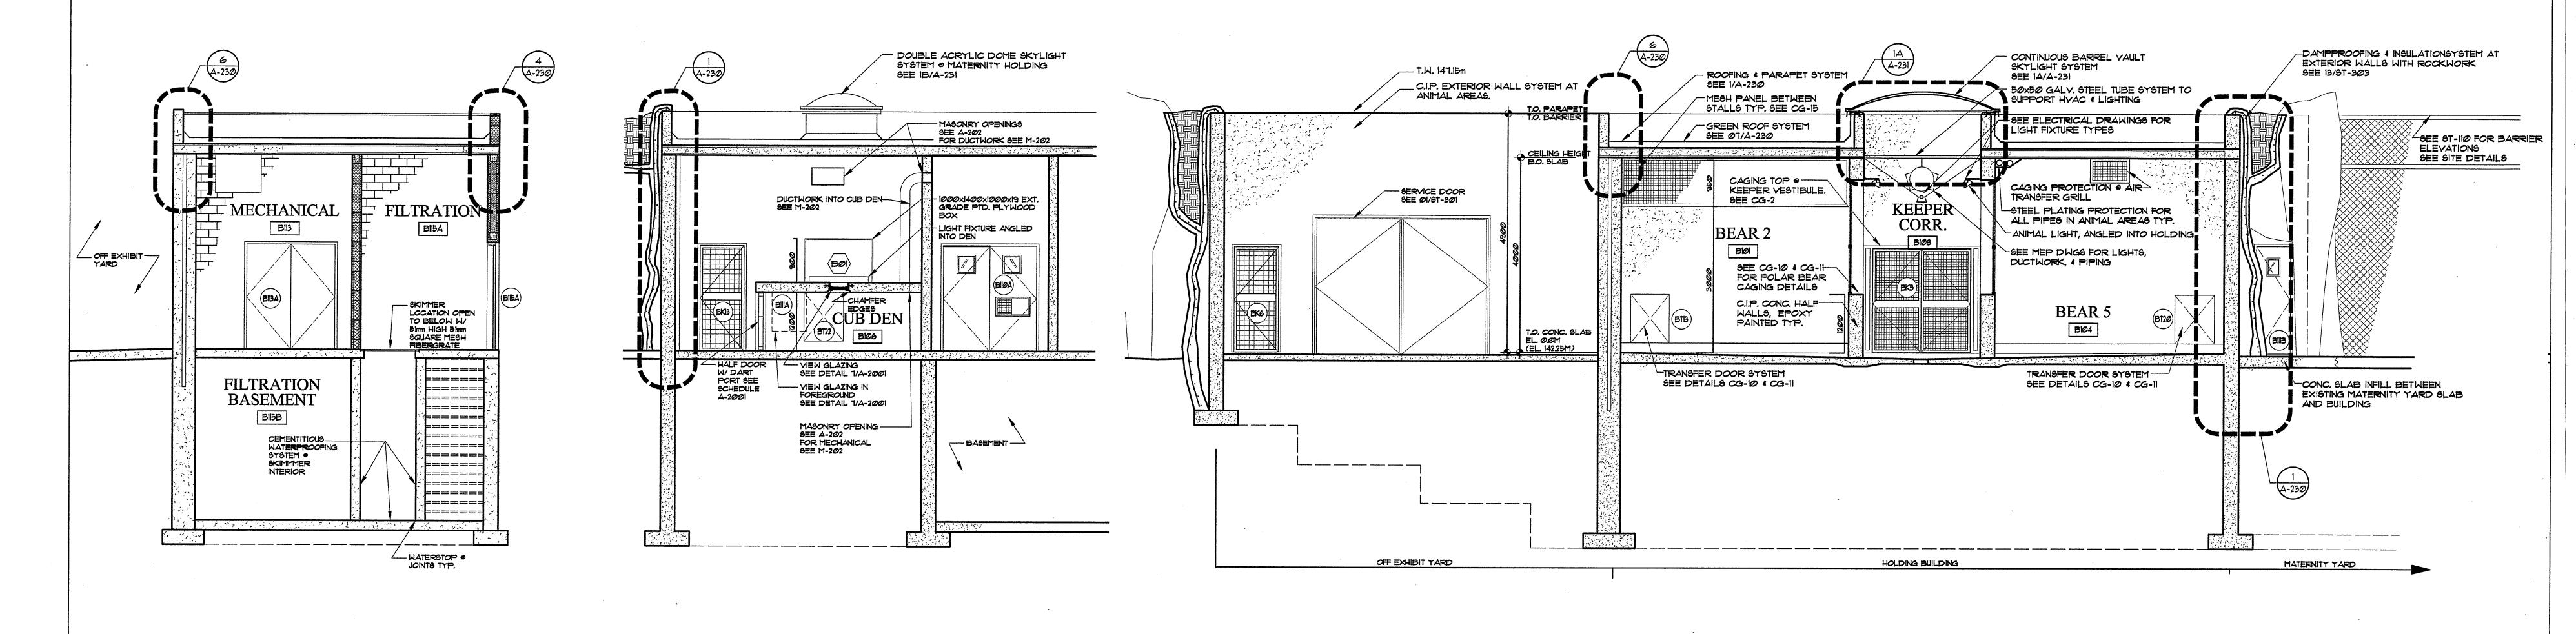

Polar Bear Holding Building - Section

SCALE: 1:50

Polar Bear Holding Building - Section A-220 SCALE: 1:50

Polar Bear Holding Building - Section





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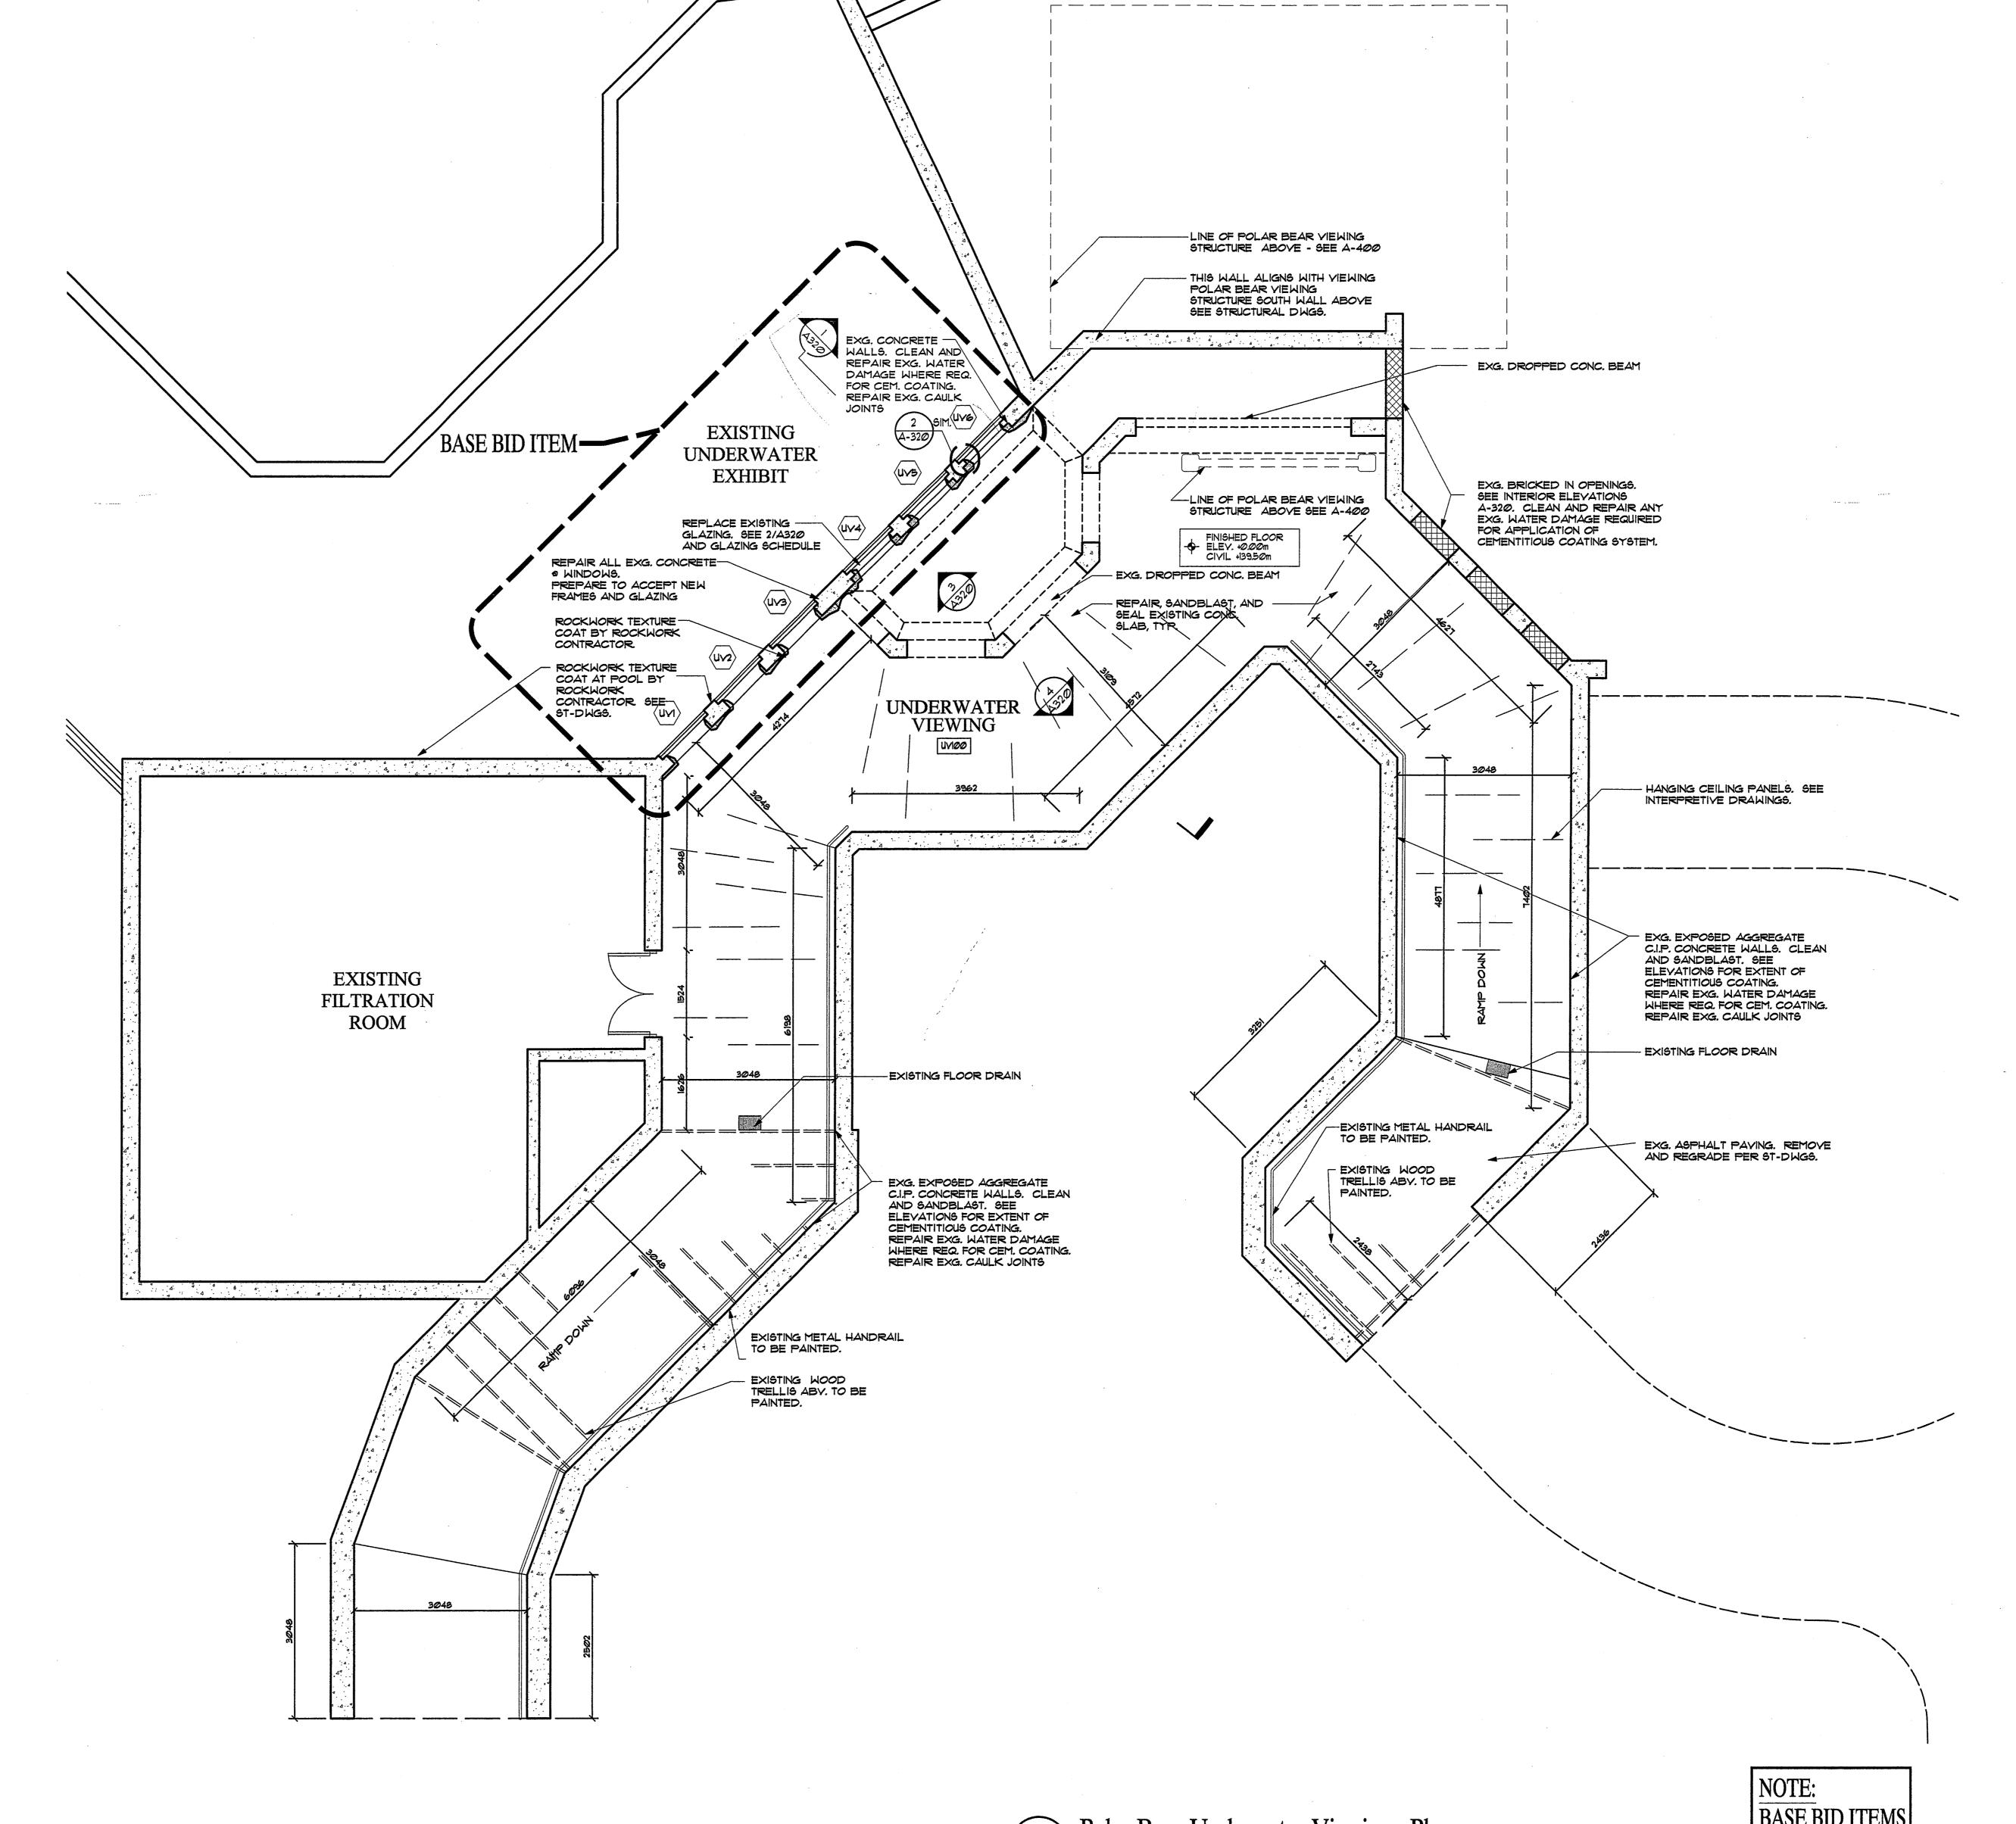


NOTE: See attached Building Code Matrix for Architect's qualification information. Polar Bear Holding Building Revisions Sections Issued for Tender and Permit - March 2, 2007

Project Number 05646 Drawing No. Project Manager JS Scale 1:50 Date March 2, 2007 Checked JB General Notes:

A-220

NOTE: ALL DIMENSIONS ARE MILLIMETERS (mm) UNLESS OTHERWISE NOTED



1 Polar Bear Underwater Viewing - Plan A-300 SCALE: 1:50

BASE BID ITEMS ON THIS SHEET. (AS NOTED) ALTERNATE #5

Issued for Tender and Permit - March 2, 2007

Revisions

NOTE: ALL DIMENSIONS ARE MILLIMETERS (mm) UNLESS OTHERWISE NOTED. NOTE: See attached Building Code Matrix for Architect's qualification information.

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CMU block

GENERAL NOTES

Contractor shall verify all dimensions and conditions prior to inception of work and shall notify Architect of any discrepancies.

2. All dimensions, except as noted, are to outside face of CMU. or outside face of partition.

3. Contractors will be required to fill and grout cracks, crevices, and holes on walls, ceilings, and floors for a smooth flush surface with no apparent

4. Refer to "CG" sheets for layout and details of all caging, keeper, and transfer doors.

5. Floor elevations will vary in the keeper and animal areas in order to accommodate a min. 2% slope to drains. See drainage plan for details.

6. See "Floor Plans" for fire-rated partitions. All

7. See finish schedule A-2001 for wall, floor, and

ceiling surface treatments.

I Hr. Fire Partition 2 Hr. Fire Partition

blanter detail.

caging abv.

Cast in place concrete

CMU block, core-insulated

Cast in place concrete half wall,

SYMBOL LEGEND

penstrations thru fire-rated walls shall be fire and

smoke sealed with a UL approved fire sealant system.

Door Identification Number - See A-2001 for Door Schedules

Number - See A-2001 for details

— Masonry Opening Identification No.

— Masonry Opening Sill Height AFF. NOTE: Refer to floor plans AND

- Masonry Opening Width x Height in mm

reflected ceiling plans for masonry opening sizes and locations see A-2001 for opening sizes • windows

Cast in place concrete with artificial rockwork, dampproofing, drainage 4 insulation. See 11/57-303 for gunite

Polar Bear Underwater Viewing Area Plan

Project Number 05646 Project Manager JS Drawn JK Checked Scale 1:50 Date March 2, 2007 General Notes:

Drawing No. A-300

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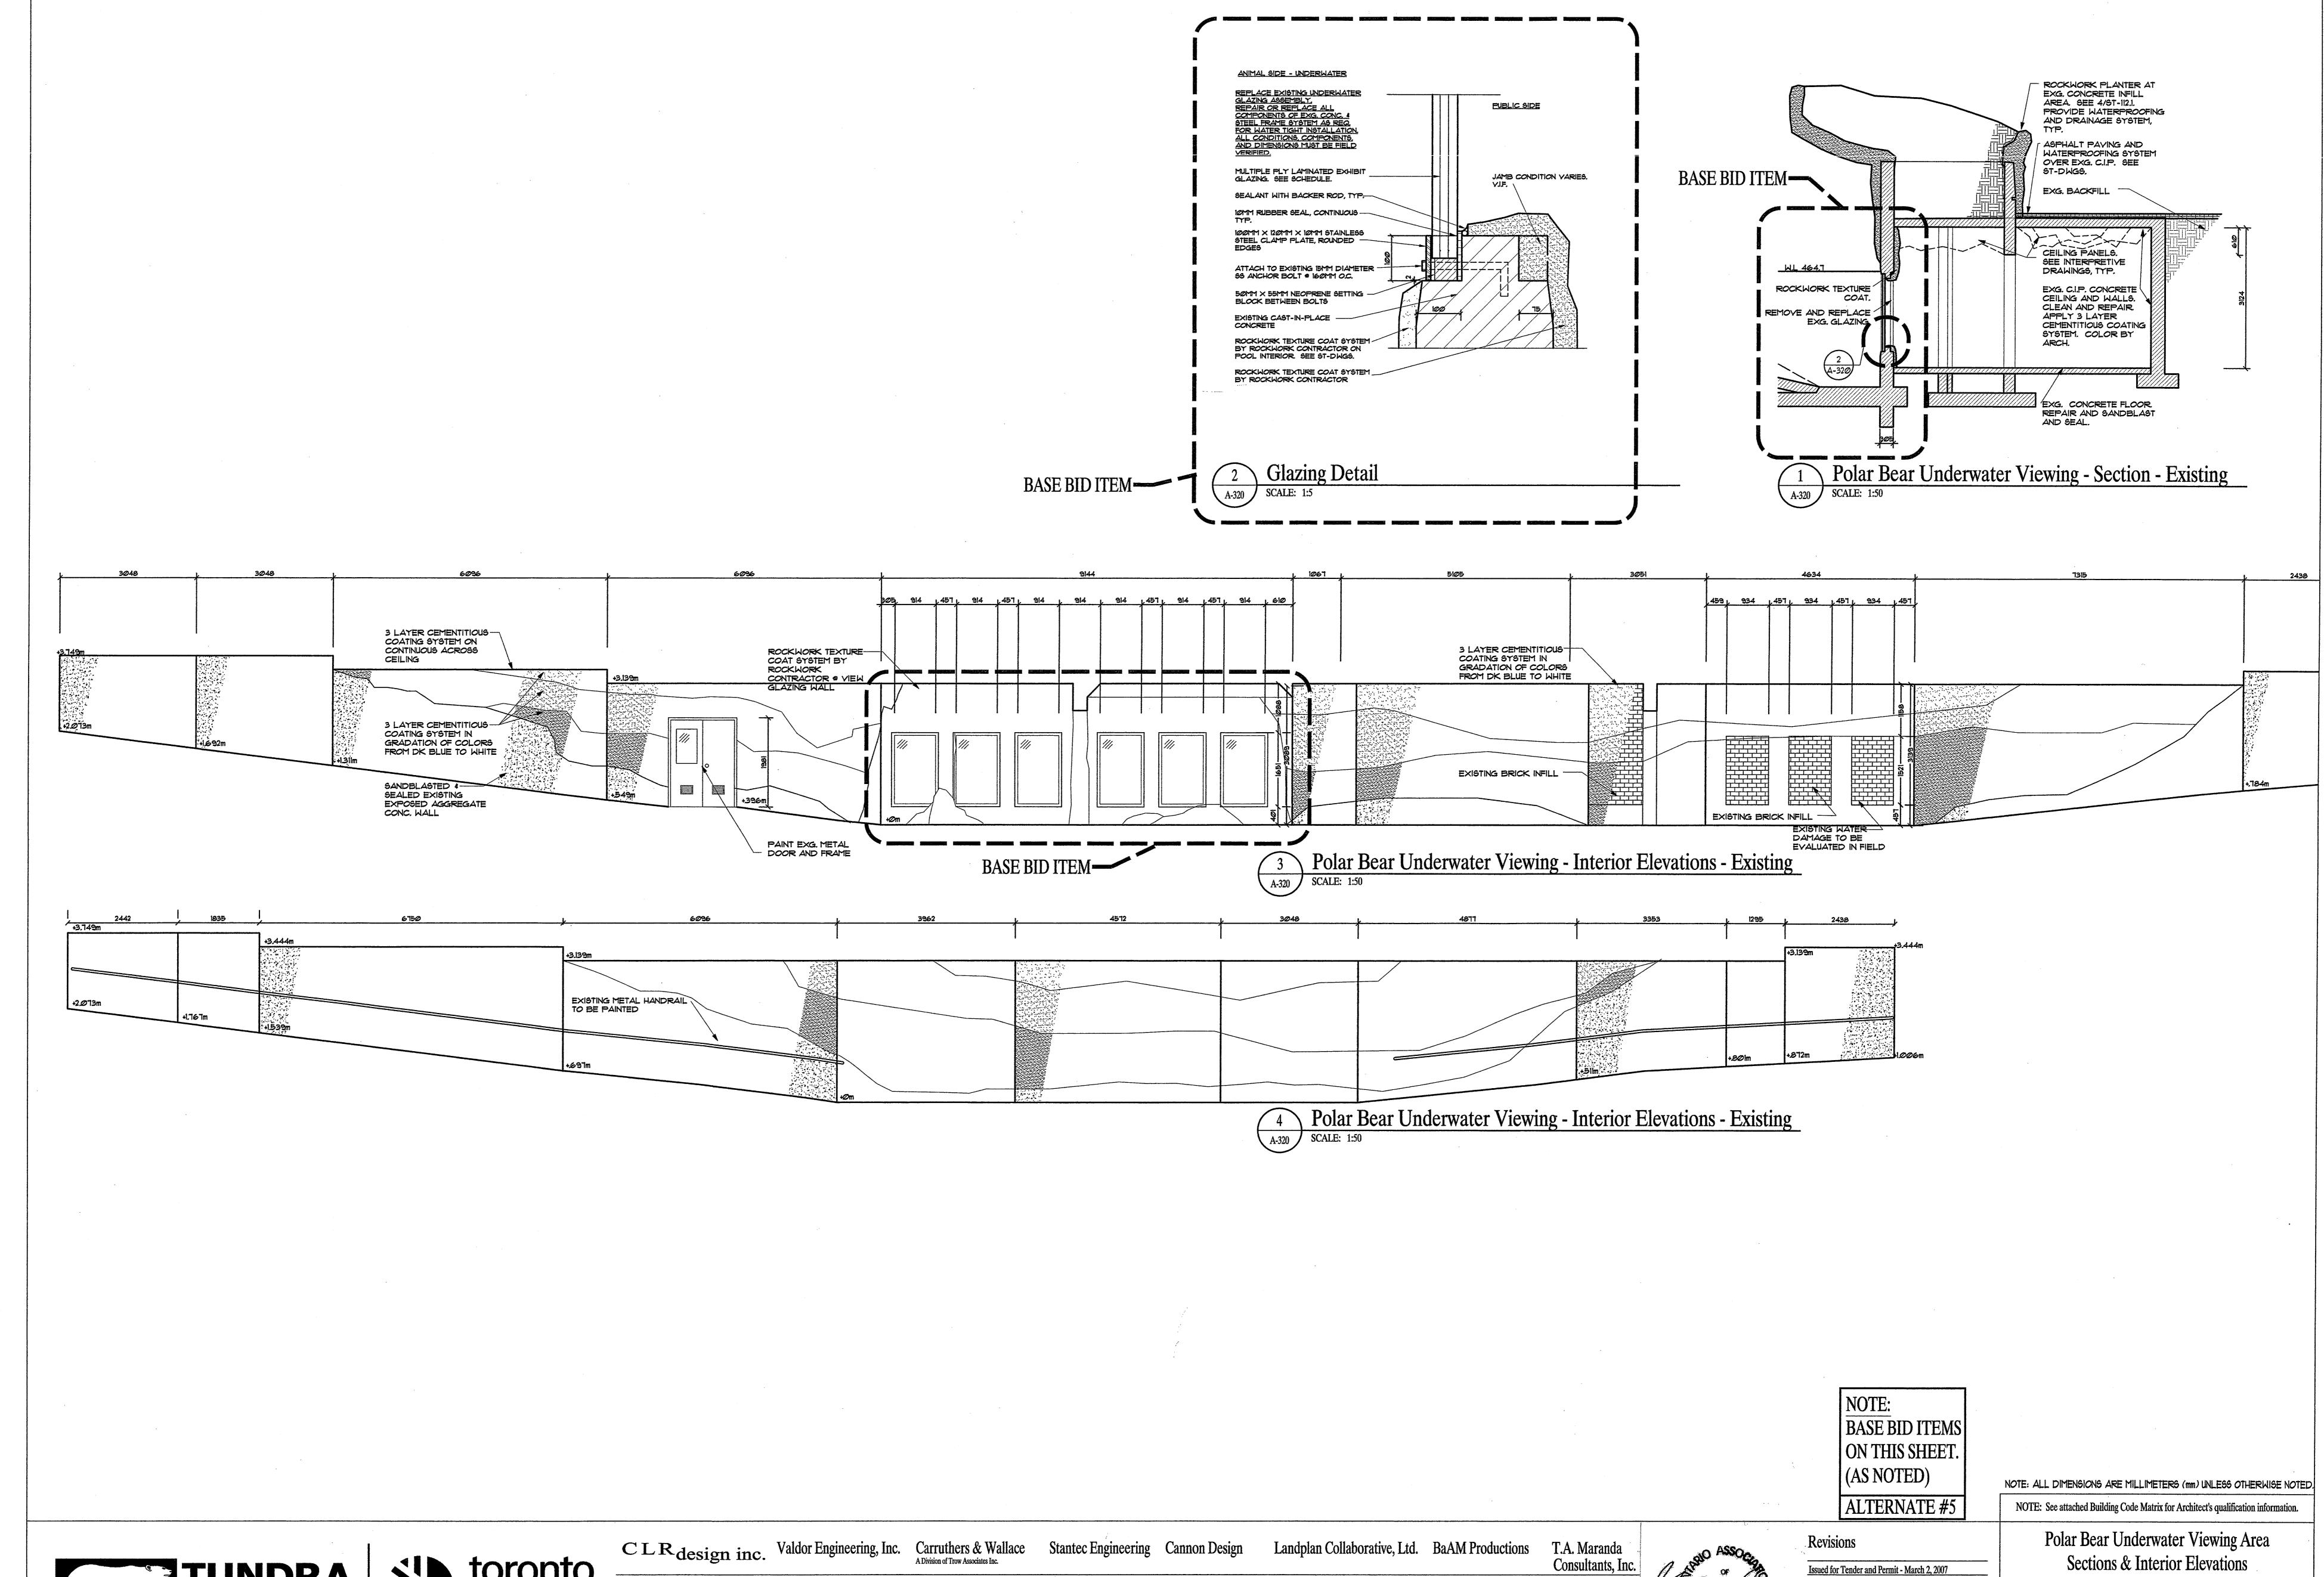
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Sections & Interior Elevations Drawing No.

Project Number 05646
Project Manager JS Scale 1:50 Checked Date March 2, 2007 General Notes:

A-320